
# **01.10 - ILLUMINATION**INDEX OF DRAWINGS

DRAWING NUMBER	DRAWING TITLE	DRAWING NUMBER	DRAWING TITLE
LTG-01	ILLUMINATION INDEX OF DRAWINGS		
LTG-02	LIGHTING PLAN - 1		
LTG-03	LIGHTING PLAN - 2		
LTG-04	LIGHTING PLAN - 3		
LTG-05	LIGHTING PLAN - 4		
LTG-06	LIGHTING PLAN - 5		
LTG-07	LIGHTING DETAIL - 1		
LTG-08	LIGHTING DETAIL - 2		

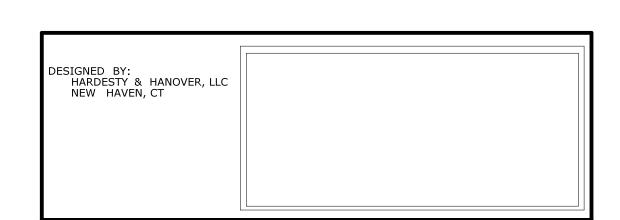

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-	-	-	_	THE INFORMATION, INCLUDING ESTIMATED	
-	-	-	_	QUANTITIES OF WORK, SHOWN ON THESE SHEETS IS BASED ON LIMITED	CHE
-	-	-	-	INVESTIGATIONS BY THE STATE AND IS IN NO WAY WARRANTED TO INDICATE	
-	-	-	-	THE CONDITIONS OF ACTUAL QUANTITIES	
-	-	-	-	OF WORK WHICH WILL BE REQUIRED.	
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REV.	DATE	REVISION DESCRIPTION	SHEET NO.	Plotted Date: 7/5/2016	

)	DESIGNER/DRAFTER:	MD
	CHECKED BY:	SDH


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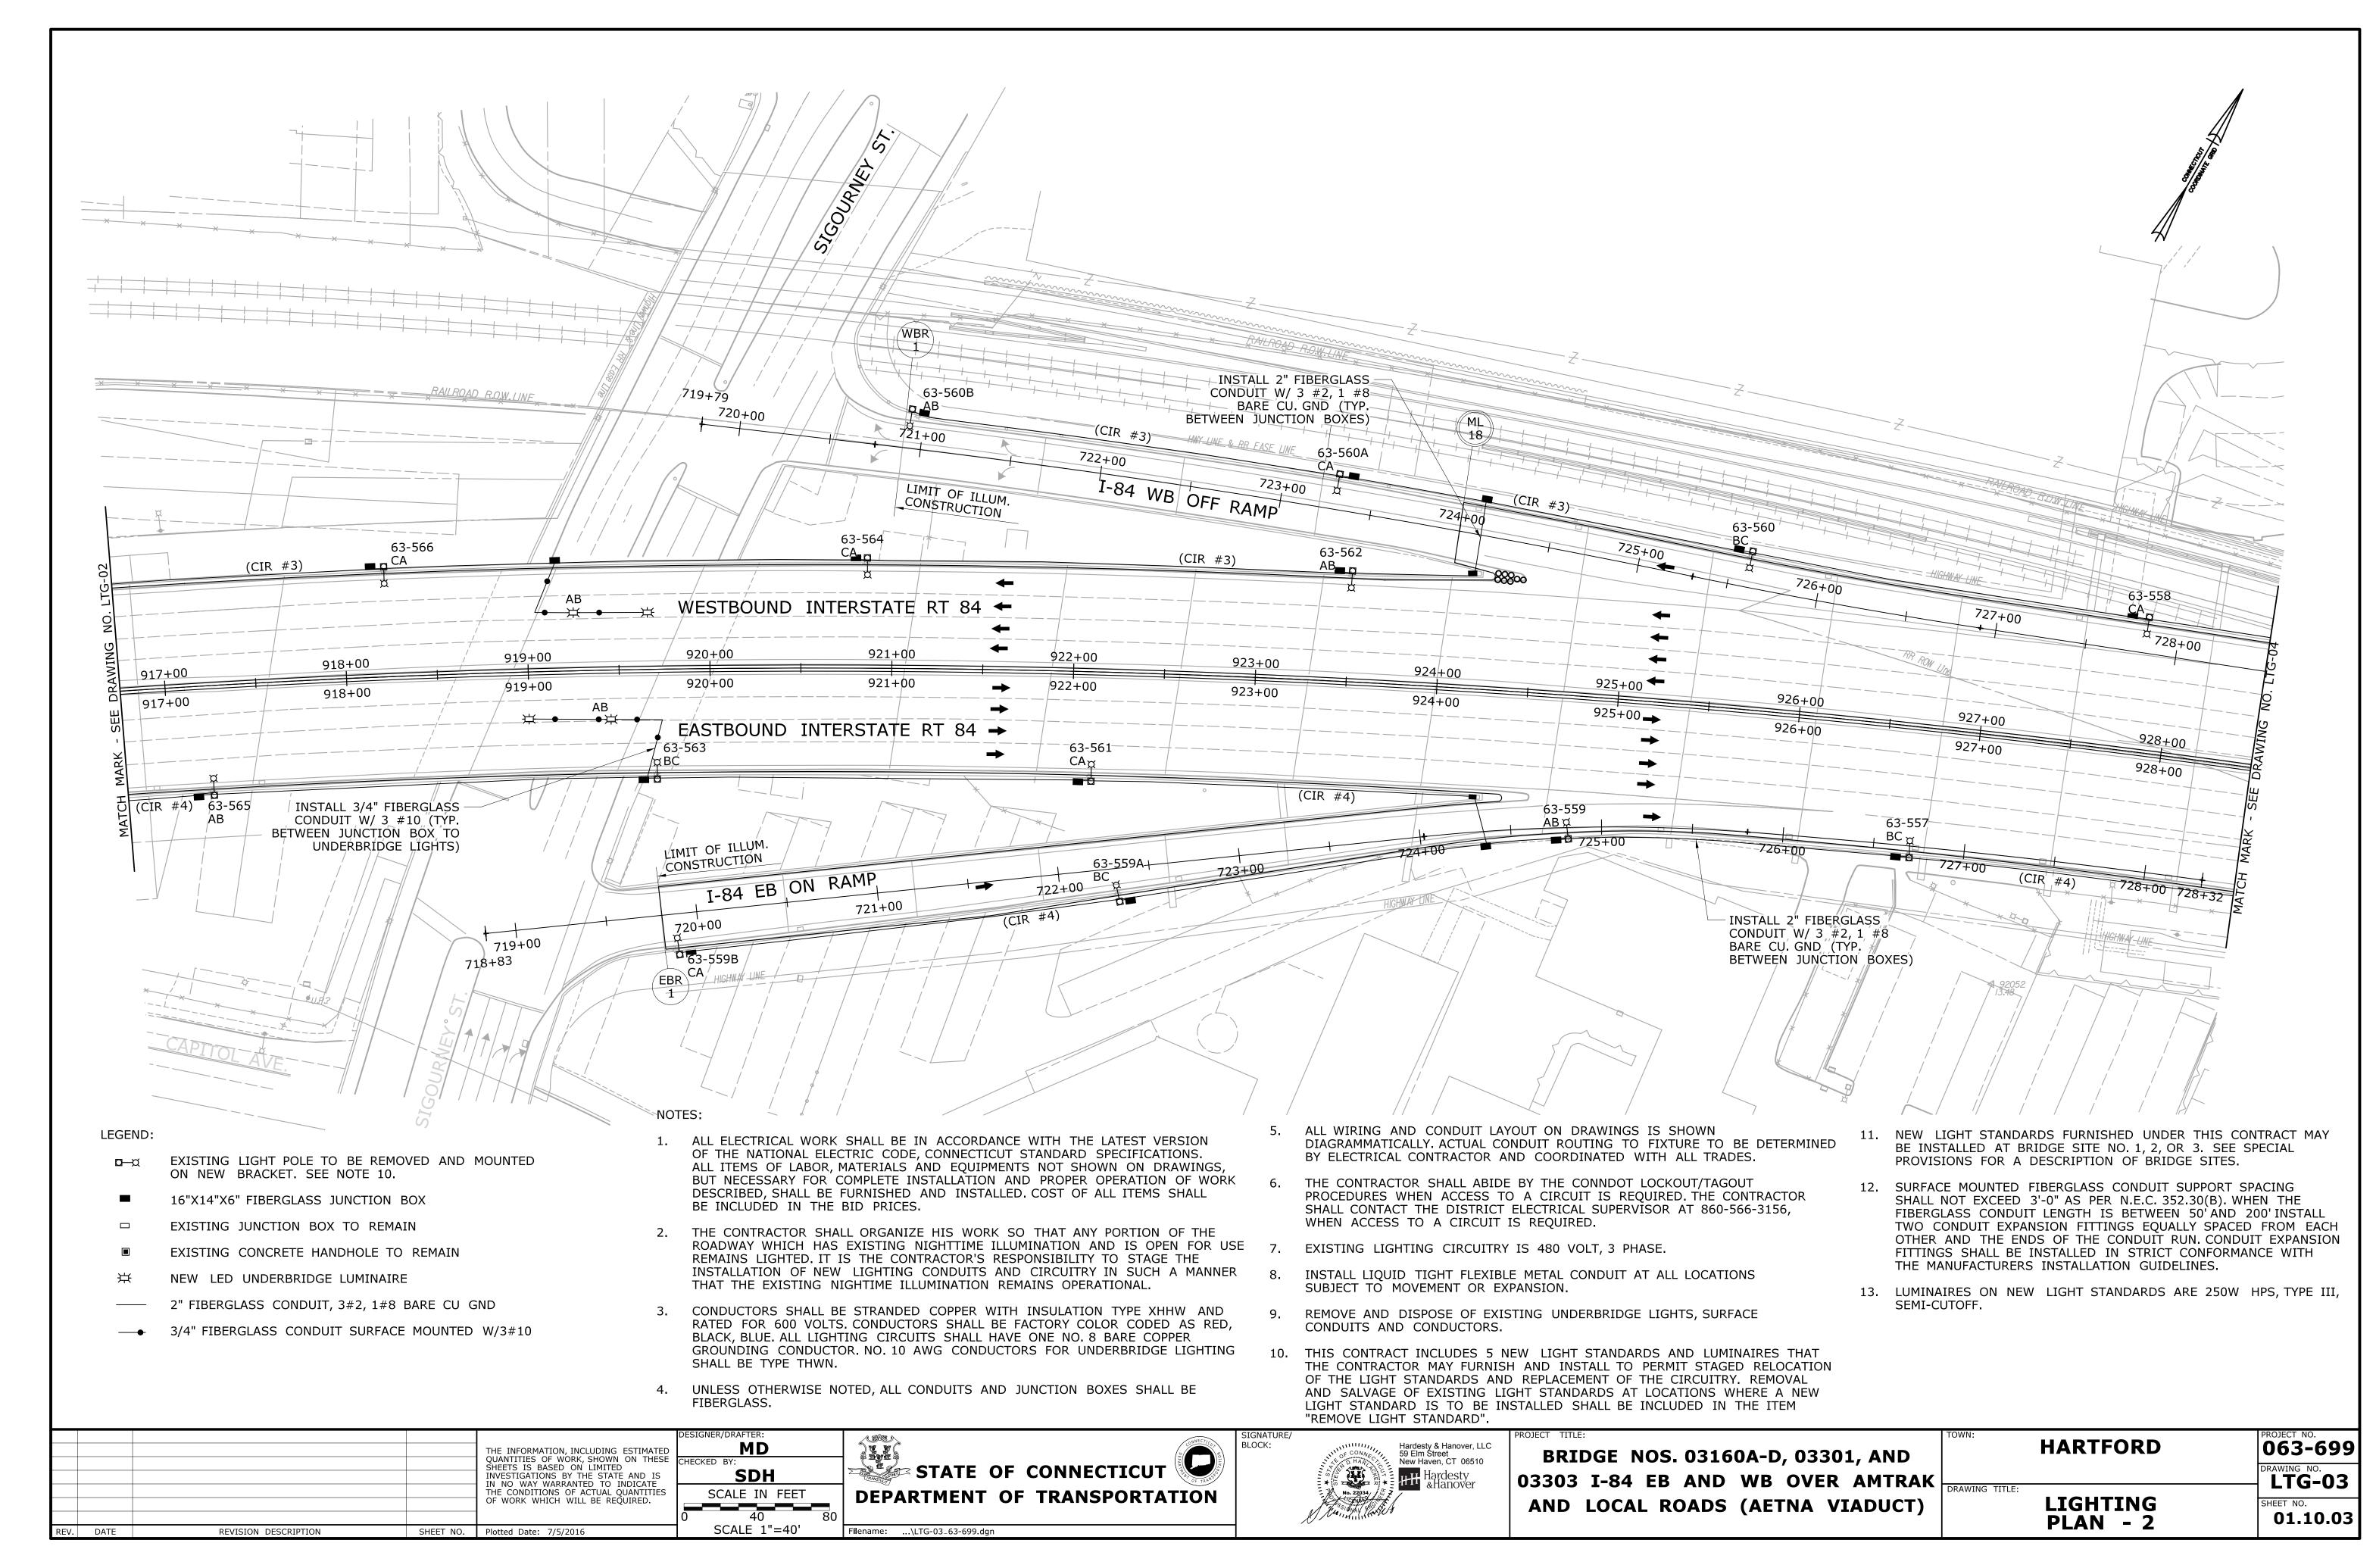





BRIDGE NO. 03160A-D, 3301 &	L
3303 I-84 EB/WB OVER AMTRAK	
& LOCAL ROADS (AETNA VIADUCT)	

	HARTFORD	PROJECT NO. <b>63-699</b>
<	DRAWING TITLE:	LTG-01
T)	ILLUMINATION INDEX OF DRAWINGS	SHEET NO. <b>01.10.01</b>



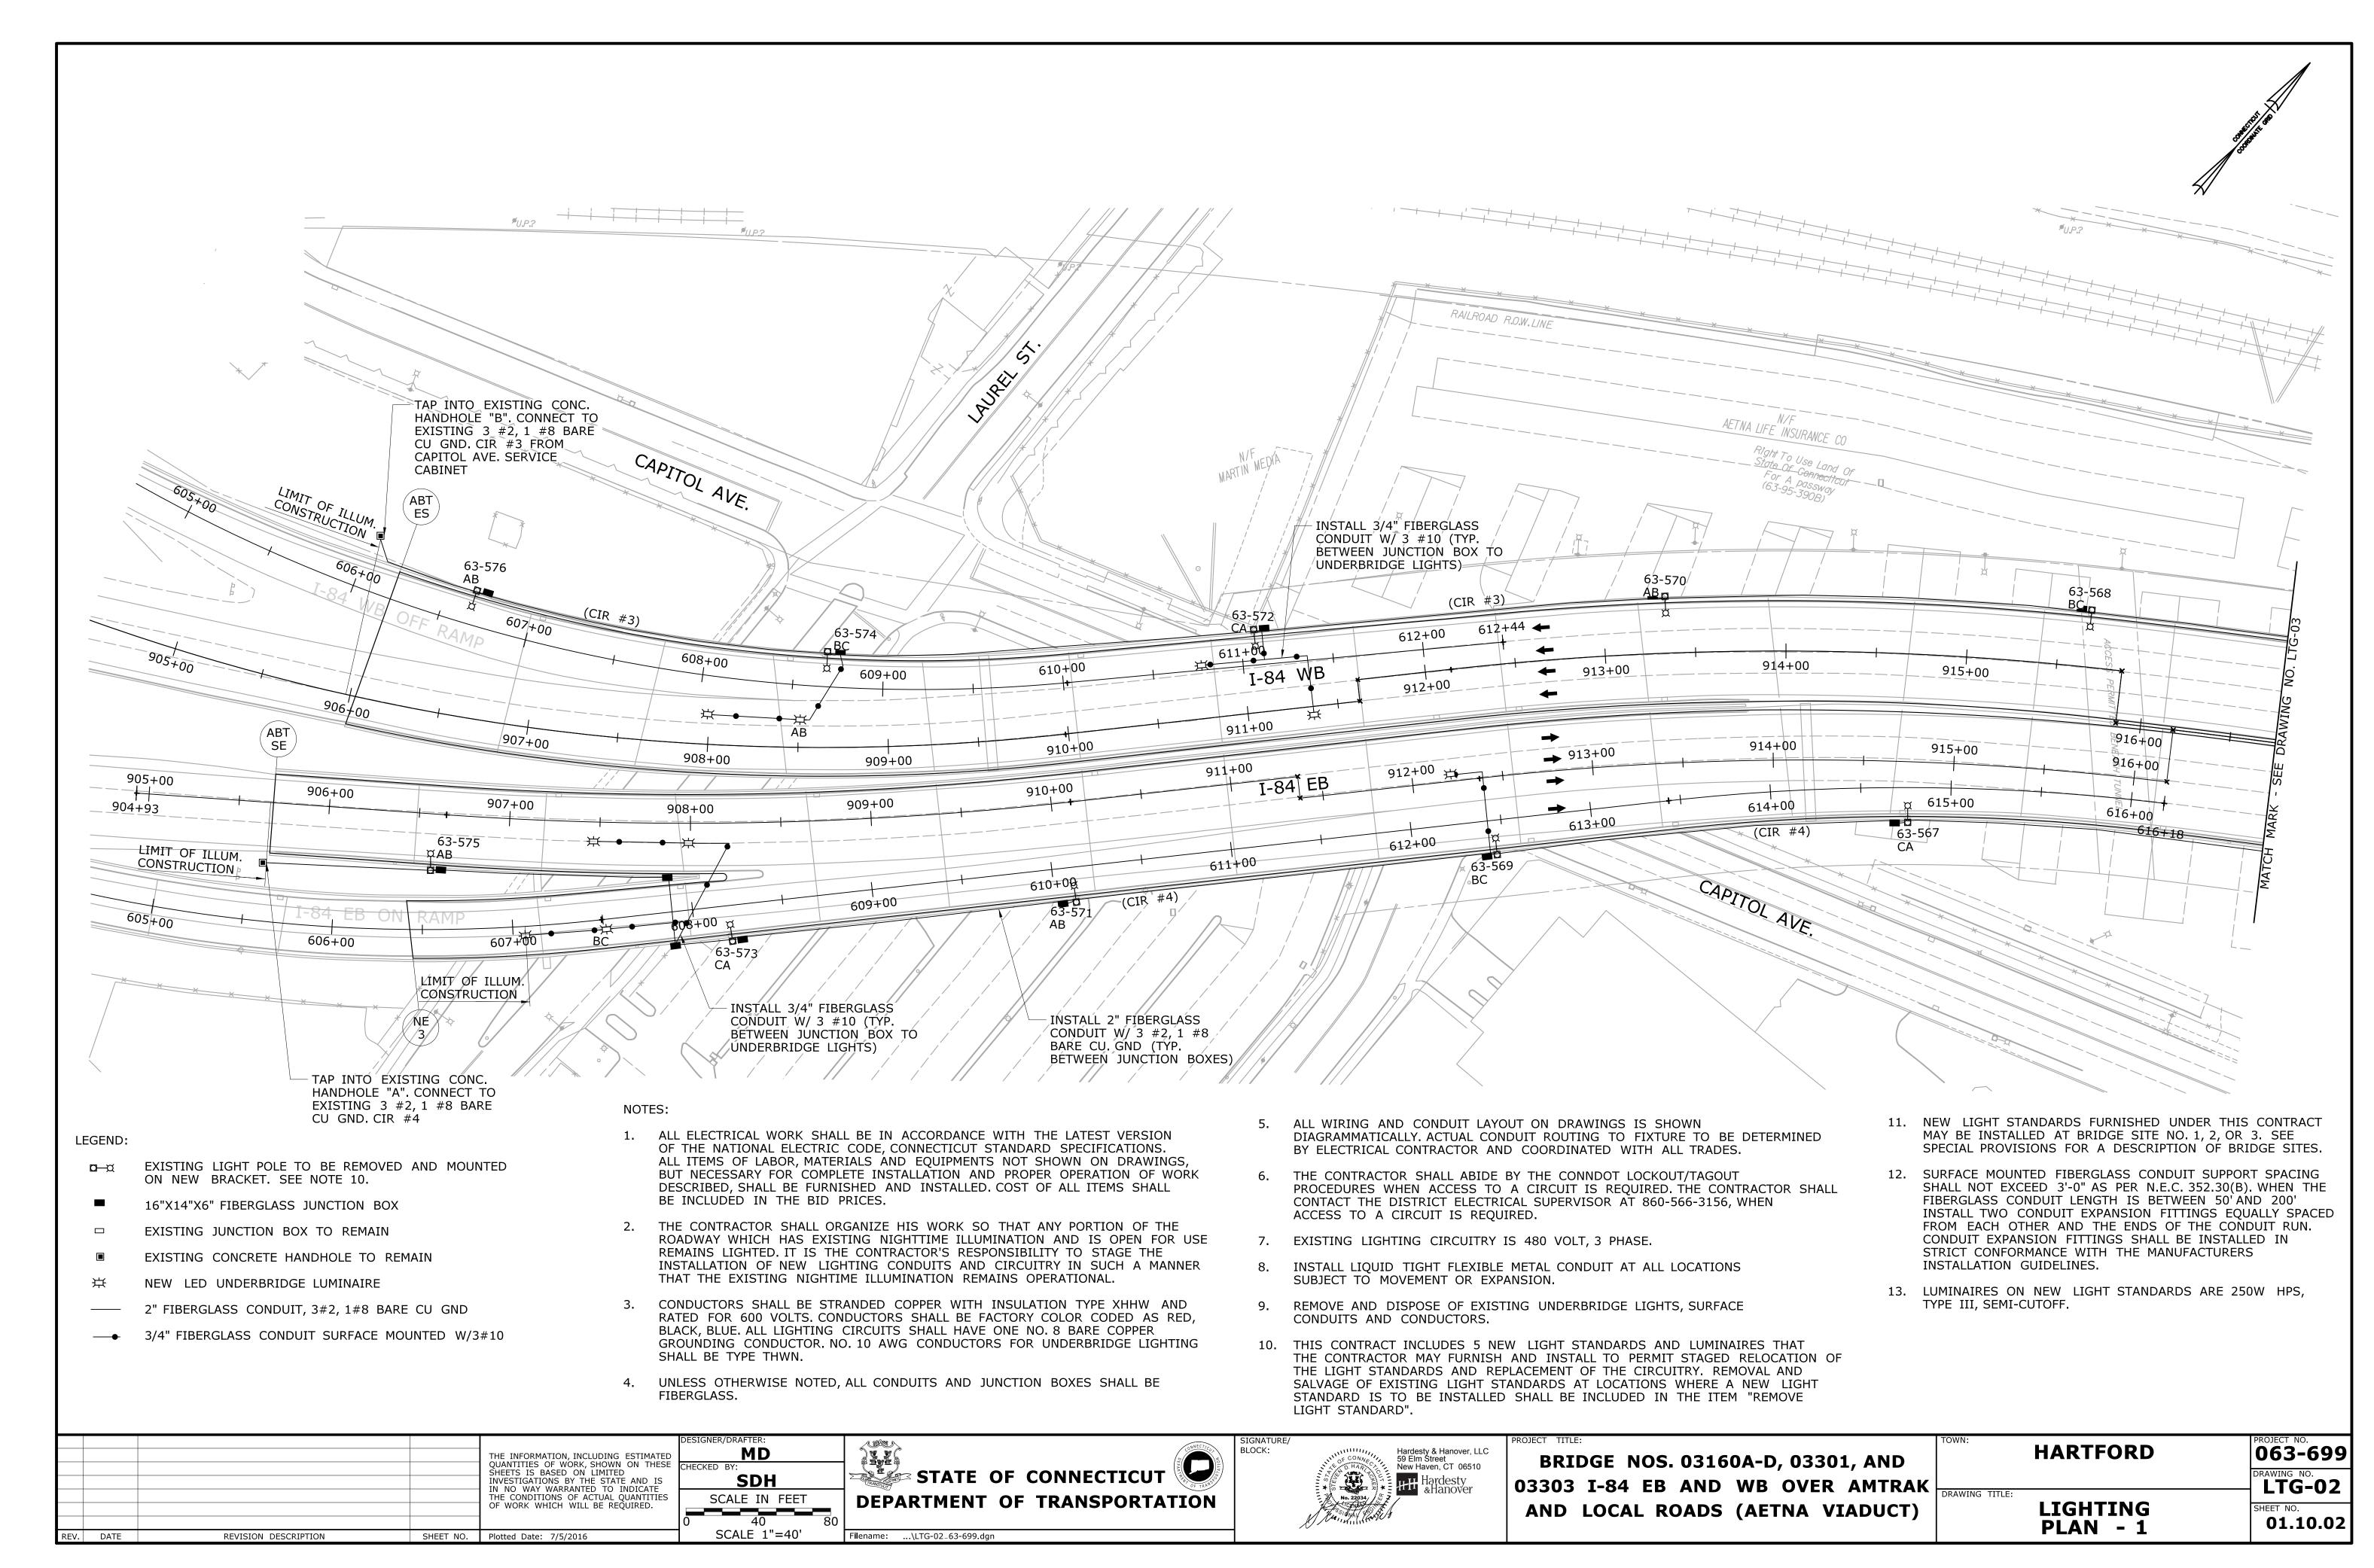

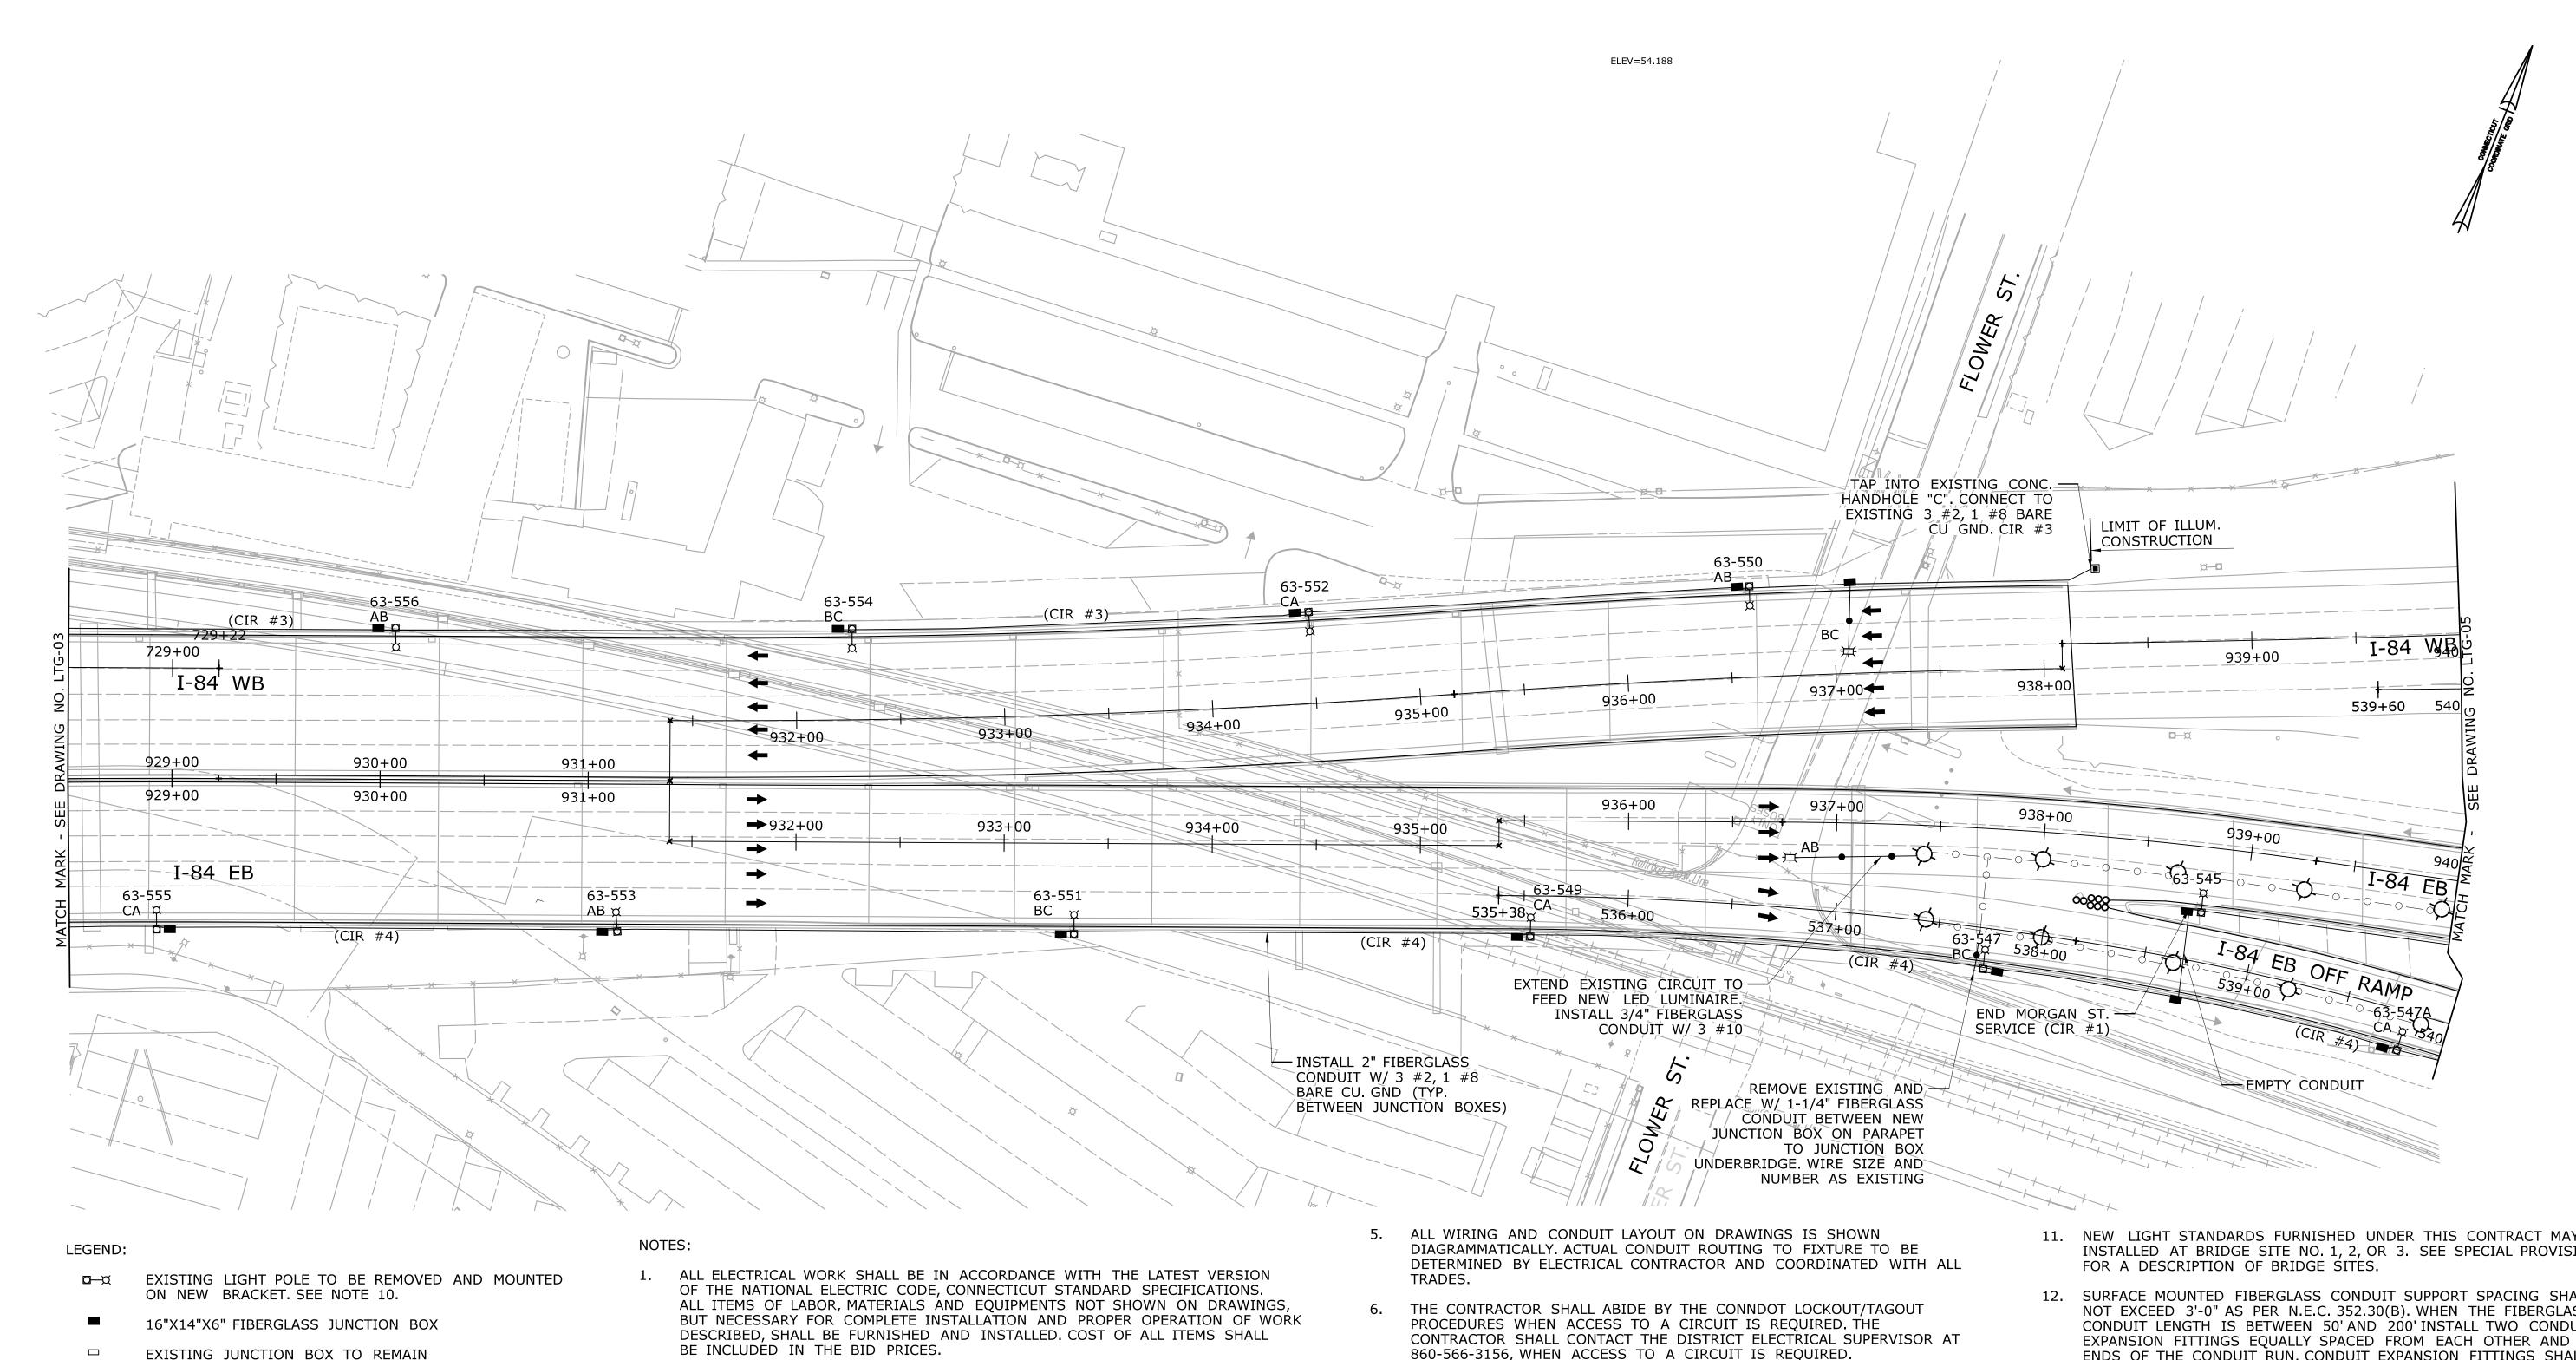

- EXISTING JUNCTION BOX TO REMAIN
- EXISTING CONCRETE HANDHOLE TO REMAIN
- NEW LED UNDERBRIDGE LUMINAIRE
- 2" FIBERGLASS CONDUIT, 3#2, 1#8 BARE CU GND
- 3/4" FIBERGLASS CONDUIT SURFACE MOUNTED W/3#10
- EXISTING UNDERBRIDGE LUMINAIRE TO REMAIN
- EXISTING UNDERBRIDGE CONDUIT TO REMAIN
- THE CONTRACTOR SHALL ORGANIZE HIS WORK SO THAT ANY PORTION OF THE ROADWAY WHICH HAS EXISTING NIGHTTIME ILLUMINATION AND IS OPEN FOR USE REMAINS LIGHTED. IT IS THE CONTRACTOR'S RESPONSIBILITY TO STAGE THE INSTALLATION OF NEW LIGHTING CONDUITS AND CIRCUITRY IN SUCH A MANNER THAT THE EXISTING NIGHTIME ILLUMINATION REMAINS OPERATIONAL.
- CONDUCTORS SHALL BE STRANDED COPPER WITH INSULATION TYPE XHHW AND RATED FOR 600 VOLTS. CONDUCTORS SHALL BE FACTORY COLOR CODED AS RED, BLACK, BLUE. ALL LIGHTING CIRCUITS SHALL HAVE ONE NO. 8 BARE COPPER GROUNDING CONDUCTOR. NO. 10 AWG CONDUCTORS FOR UNDERBRIDGE LIGHTING SHALL BE TYPE THWN.
- UNLESS OTHERWISE NOTED, ALL CONDUITS AND JUNCTION BOXES SHALL BE FIBERGLASS.


- 860-566-3156, WHEN ACCESS TO A CIRCUIT IS REQUIRED.
- EXISTING LIGHTING CIRCUITRY IS 480 VOLT, 3 PHASE.
- INSTALL LIQUID TIGHT FLEXIBLE METAL CONDUIT AT ALL LOCATIONS SUBJECT TO MOVEMENT OR EXPANSION.
- REMOVE AND DISPOSE OF EXISTING UNDERBRIDGE LIGHTS, SURFACE CONDUITS AND CONDUCTORS.
- 10. THIS CONTRACT INCLUDES 5 NEW LIGHT STANDARDS AND LUMINAIRES THAT THE CONTRACTOR MAY FURNISH AND INSTALL TO PERMIT STAGED RELOCATION OF THE LIGHT STANDARDS AND REPLACEMENT OF THE CIRCUITRY. REMOVAL AND SALVAGE OF EXISTING LIGHT STANDARDS AT LOCATIONS WHERE A NEW LIGHT STANDARD IS TO BE INSTALLED SHALL BE INCLUDED IN THE ITEM "REMOVE LIGHT STANDARD".

- 11. NEW LIGHT STANDARDS FURNISHED UNDER THIS CONTRACT MAY BE INSTALLED AT BRIDGE SITE NO. 1, 2, OR 3. SEE SPECIAL PROVISIONS
- SURFACE MOUNTED FIBERGLASS CONDUIT SUPPORT SPACING SHALL NOT EXCEED 3'-0" AS PER N.E.C. 352.30(B). WHEN THE FIBERGLASS CONDUIT LENGTH IS BETWEEN 50' AND 200' INSTALL TWO CONDUIT EXPANSION FITTINGS EQUALLY SPACED FROM EACH OTHER AND THE ENDS OF THE CONDUIT RUN. CONDUIT EXPANSION FITTINGS SHALL BE INSTALLED IN STRICT CONFORMANCE WITH THE MANUFACTURERS INSTALLATION GUIDELINES.
- 13. LUMINAIRES ON NEW LIGHT STANDARDS ARE 250W HPS, TYPE III, SEMI-CUTOFF.

THE INFORMATION, INCLUDING ESTIMATED QUANTITIES OF WORK, SHOWN ON THESE SHEETS IS BASED ON LIMITED INVESTIGATIONS BY THE STATE AND IS IN NO WAY WARRANTED TO INDICATE THE CONDITIONS OF ACTUAL QUANTITIES OF WORK WHICH WILL BE REQUIRED. REVISION DESCRIPTION SHEET NO. Plotted Date: 7/5/2016 EV. DATE

MD SDH SCALE IN FEET SCALE 1"=40' Filename: ...\LTG-04\_63-699.dgn


STATE OF CONNECTICUT **DEPARTMENT OF TRANSPORTATION** 

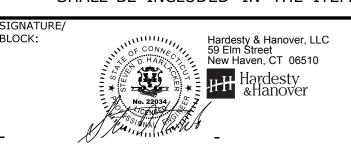


BRIDGE NOS. 03160A-D, 03301, AND 03303 I-84 EB AND WB OVER AMTRAK DRAWING TITLE: AND LOCAL ROADS (AETNA VIADUCT)


**HARTFORD** 063-699 **LTG-04 LIGHTING** 01.10.04 PLAN - 3

### NOTES: ALL ELECTRICAL WORK SHALL BE IN ACCORDANCE WITH THE LATEST VERSION THE CONTRACTOR SHALL ABIDE BY THE CONNDOT LOCKOUT/TAGOUT 11. NEW LIGHT STANDARDS FURNISHED UNDER THIS CONTRACT OF THE NATIONAL ELECTRIC CODE, CONNECTICUT STANDARD SPECIFICATIONS. PROCEDURES WHEN ACCESS TO A CIRCUIT IS REQUIRED. THE MAY BE INSTALLED AT BRIDGE SITE NO. 1, 2, OR 3. SEE CONTRACTOR SHALL CONTACT THE DISTRICT ELECTRICAL ALL ITEMS OF LABOR, MATERIALS AND EQUIPMENTS NOT SHOWN ON DRAWINGS, SPECIAL PROVISIONS FOR A DESCRIPTION OF BRIDGE SITES. BUT NECESSARY FOR COMPLETE INSTALLATION AND PROPER OPERATION OF WORK SUPERVISOR AT 860-566-3156, WHEN ACCESS TO A CIRCUIT IS DESCRIBED, SHALL BE FURNISHED AND INSTALLED. COST OF ALL ITEMS SHALL REQUIRED. 12. SURFACE MOUNTED FIBERGLASS CONDUIT SUPPORT SPACING BE INCLUDED IN THE BID PRICES. SHALL NOT EXCEED 3'-0" AS PER N.E.C. 352.30(B). WHEN THE 7. EXISTING LIGHTING CIRCUITRY IS 480 VOLT, 3 PHASE. FIBERGLASS CONDUIT LENGTH IS BETWEEN 50' AND 200' 2. THE CONTRACTOR SHALL ORGANIZE HIS WORK SO THAT ANY PORTION OF THE INSTALL TWO CONDUIT EXPANSION FITTINGS EQUALLY SPACED ROADWAY WHICH HAS EXISTING NIGHTTIME ILLUMINATION AND IS OPEN FOR USE INSTALL LIQUID TIGHT FLEXIBLE METAL CONDUIT AT ALL LOCATIONS FROM EACH OTHER AND THE ENDS OF THE CONDUIT RUN. REMAINS LIGHTED. IT IS THE CONTRACTOR'S RESPONSIBILITY TO STAGE THE SUBJECT TO MOVEMENT OR EXPANSION. CONDUIT EXPANSION FITTINGS SHALL BE INSTALLED IN INSTALLATION OF NEW LIGHTING CONDUITS AND CIRCUITRY IN SUCH A MANNER STRICT CONFORMANCE WITH THE MANUFACTURERS THAT THE EXISTING NIGHTIME ILLUMINATION REMAINS OPERATIONAL. REMOVE AND DISPOSE OF EXISTING UNDERBRIDGE LIGHTS, INSTALLATION GUIDELINES. SURFACE CONDUITS AND CONDUCTORS. CONDUCTORS SHALL BE STRANDED COPPER WITH INSULATION TYPE XHHW AND 13. LUMINAIRES ON NEW LIGHT STANDARDS ARE 250W HPS, RATED FOR 600 VOLTS. CONDUCTORS SHALL BE FACTORY COLOR CODED AS RED, 10. THIS CONTRACT INCLUDES 5 NEW LIGHT STANDARDS AND TYPE III, SEMI-CUTOFF. BLACK, BLUE. ALL LIGHTING CIRCUITS SHALL HAVE ONE NO. 8 BARE COPPER LUMINAIRES THAT THE CONTRACTOR MAY FURNISH AND INSTALL TO GROUNDING CONDUCTOR. NO. 10 AWG CONDUCTORS FOR UNDERBRIDGE LIGHTING PERMIT STAGED RELOCATION OF THE LIGHT STANDARDS AND SHALL BE TYPE THWN. REPLACEMENT OF THE CIRCUITRY. REMOVAL AND SALVAGE OF EXISTING LIGHT STANDARDS AT LOCATIONS WHERE A NEW LIGHT UNLESS OTHERWISE NOTED, ALL CONDUITS AND JUNCTION BOXES SHALL BE STANDARD IS TO BE INSTALLED SHALL BE INCLUDED IN THE ITEM FIBERGLASS. "REMOVE LIGHT STANDARD". ALL WIRING AND CONDUIT LAYOUT ON DRAWINGS IS SHOWN DIAGRAMMATICALLY, ACTUAL CONDUIT ROUTING TO FIXTURE TO BE DETERMINED BY ELECTRICAL CONTRACTOR AND COORDINATED WITH ALL TRADES. SEE PROJECT 63-700 FOR LIGHTING REQUIREMENT OF BRIDGE 1765 943+00 942+6 941+00 541+00 542 +/00/ I-84 WB ON RAMP TAP ÍNTO EXISTING CONC. HANDHOLE "D". CONNECT TO ZEXISTING 3 #2, 1 #8 BARE 941+00 CU GND CIR #1, MORGAN 945+00 STREET CABINET 942+00 944+00 943+00 (CIR, #1) 63-541 I-84 EB OFF RAMPS INSTALL 2" FIBERGLASS CONDUIT W/ 3 #2, 1 #8 BARE CU. GND (TYP. BETWEEN JUNCTION BOXES) LEGEND: EXISTING LIGHT POLE TO BE REMOVED AND MOUNTED ON NEW BRACKET. SEE NOTE 10. 16"X14"X6" FIBERGLASS JUNCTION BOX 348±00 347+00 EXISTING JUNCTION BOX TO REMAIN EXISTING CONCRETE HANDHOLE TO REMAIN NEW LED UNDERBRIDGE LUMINAIRE 2" FIBERGLASS CONDUIT, 3#2, 1#8 BARE CU GND 3/4" FIBERGLASS CONDUIT SURFACE MOUNTED W/3#10 EXISTING UNDERBRIDGE LUMINAIRE TO REMAIN EXISTING UNDERBRIDGE CONDUIT TO REMAIN STATE OF CONNECTICUT **HARTFORD** 063-699 MD Hardesty & Hanover, LLC 59 Elm Street New Haven, CT 06510 THE INFORMATION, INCLUDING ESTIMATED BRIDGE NOS. 03160A-D, 03301, AND QUANTITIES OF WORK, SHOWN ON THESE SHEETS IS BASED ON LIMITED SDH 03303 I-84 EB AND WB OVER AMTRAK DRAWING TITLE: INVESTIGATIONS BY THE STATE AND IS LTG-05 IN NO WAY WARRANTED TO INDICATE THE CONDITIONS OF ACTUAL QUANTITIES OF WORK WHICH WILL BE REQUIRED. SCALE IN FEET **DEPARTMENT OF TRANSPORTATION LIGHTING** AND LOCAL ROADS (AETNA VIADUCT) 01.10.05 PLAN - 4 SCALE 1"=40' REVISION DESCRIPTION Filename: ...\LTG-05\_63-699.dgn EV. DATE SHEET NO. Plotted Date: 7/5/2016

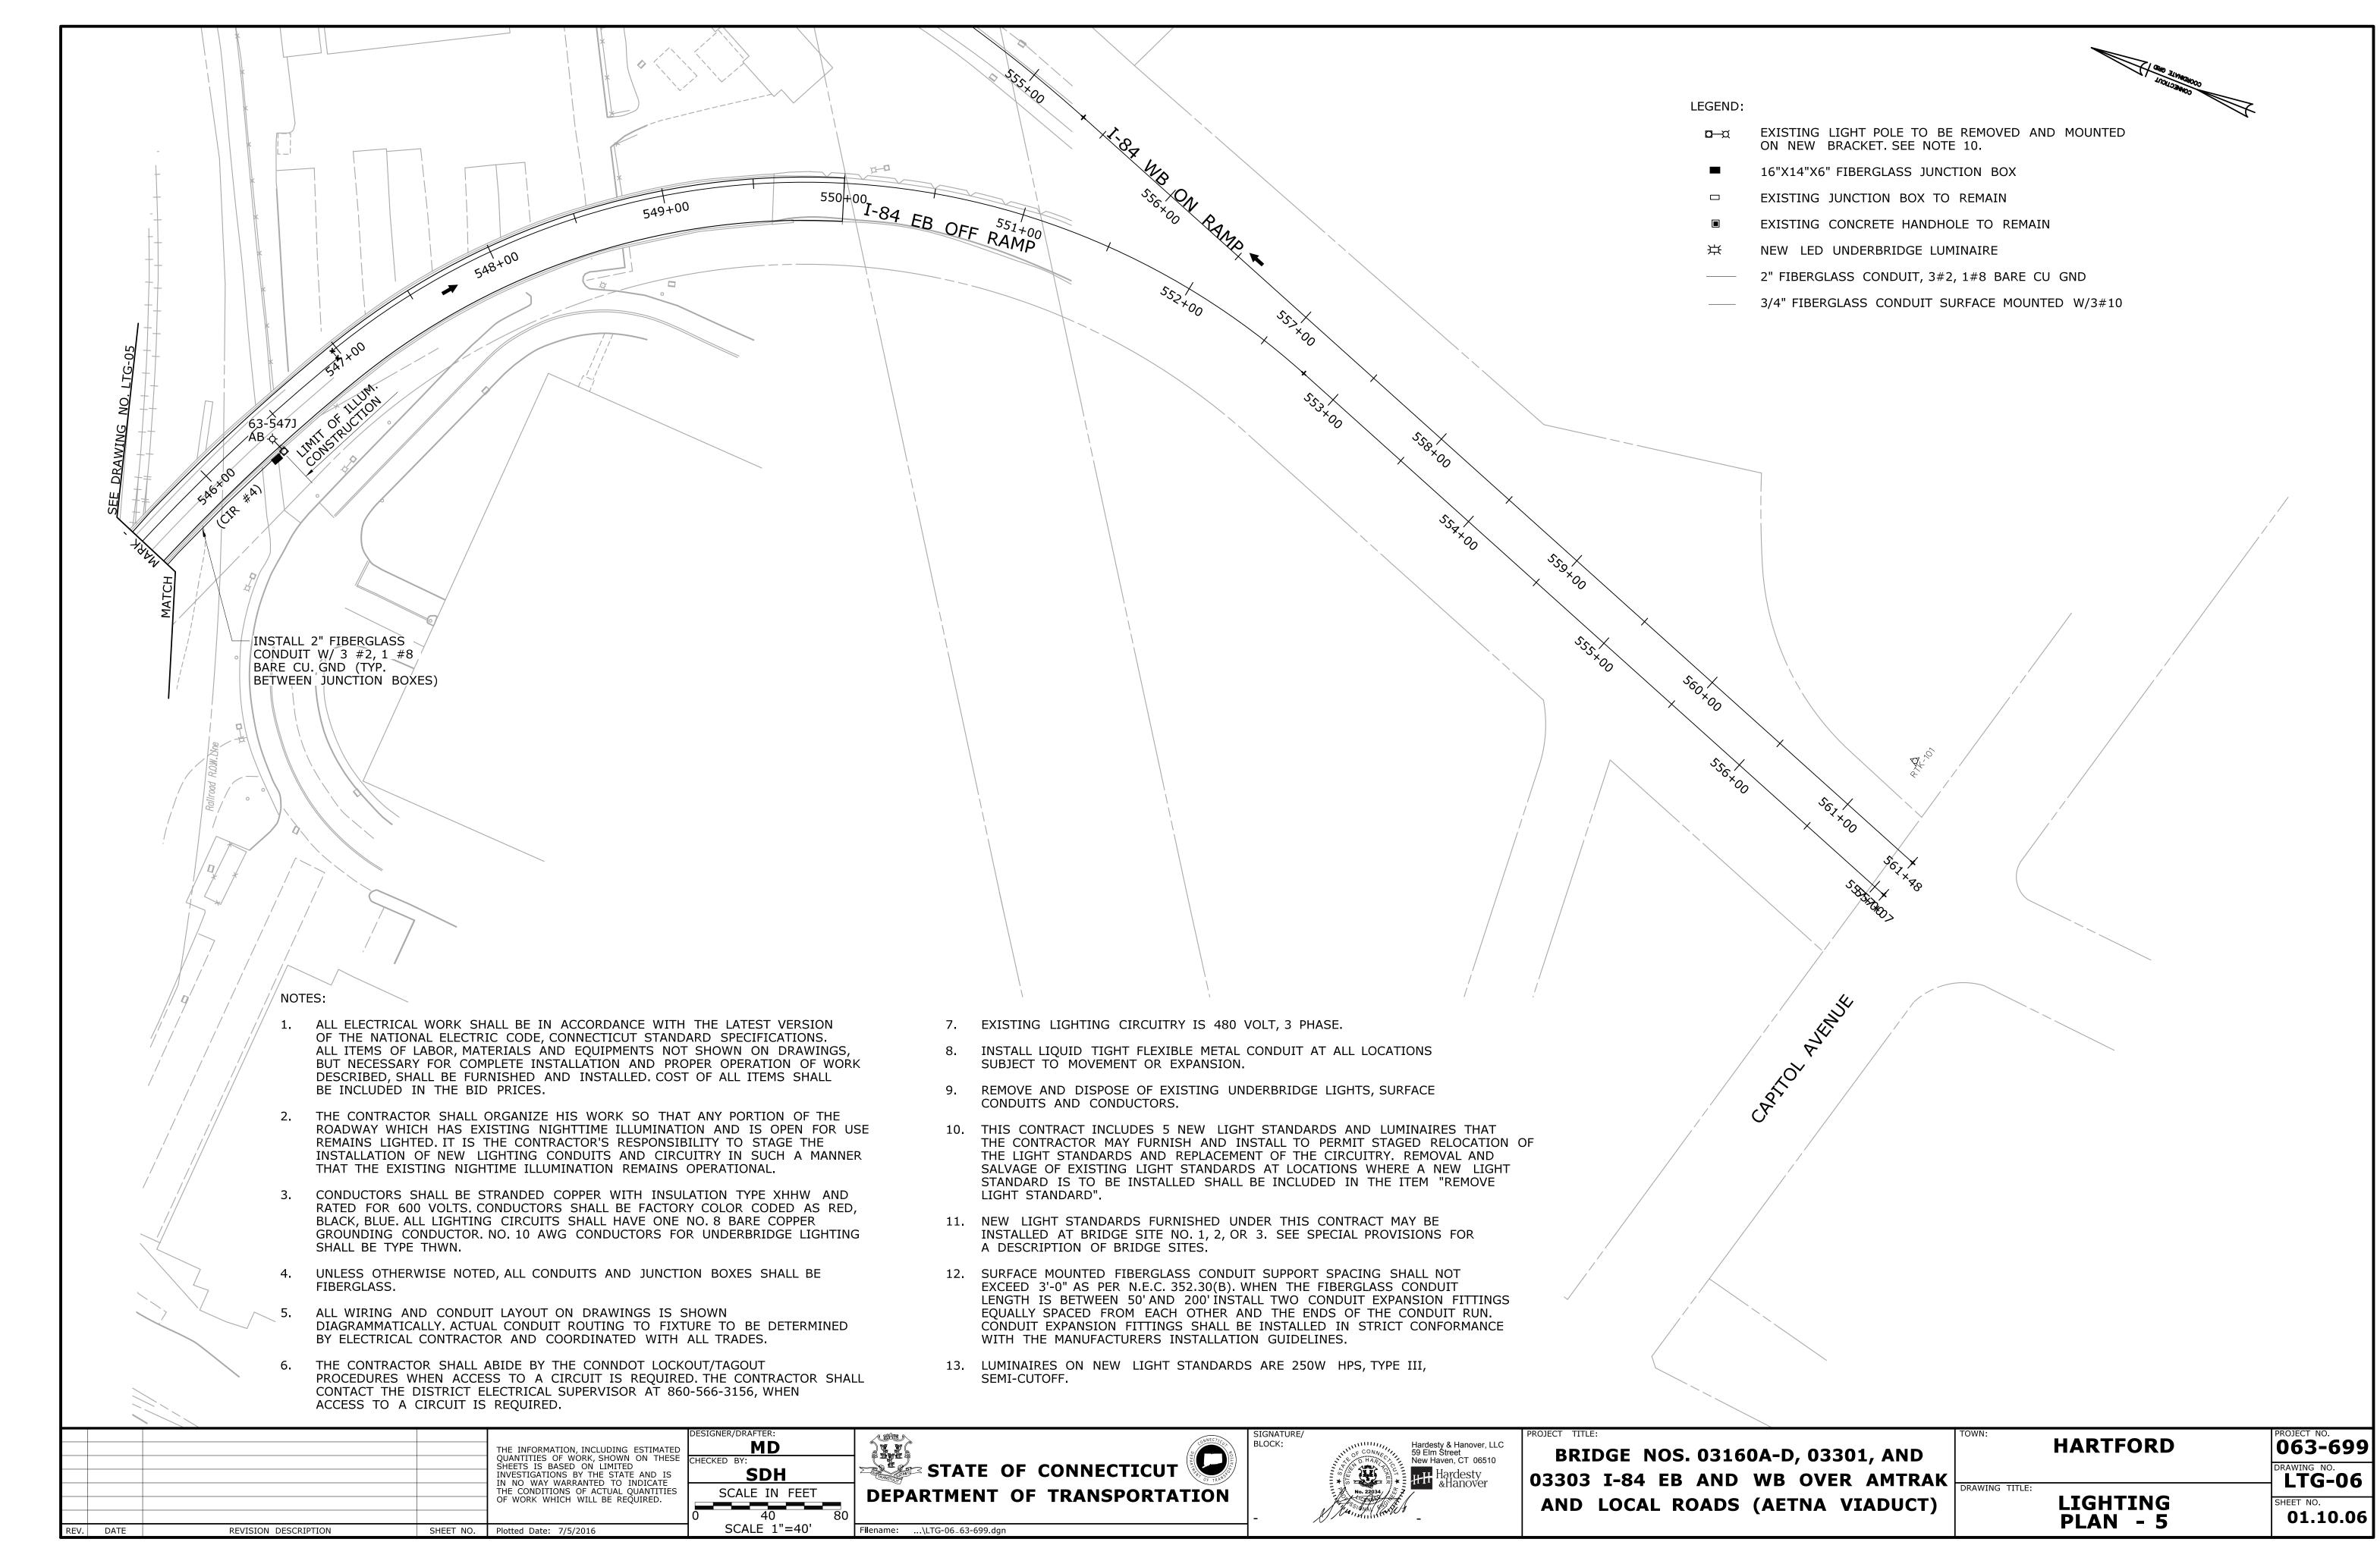

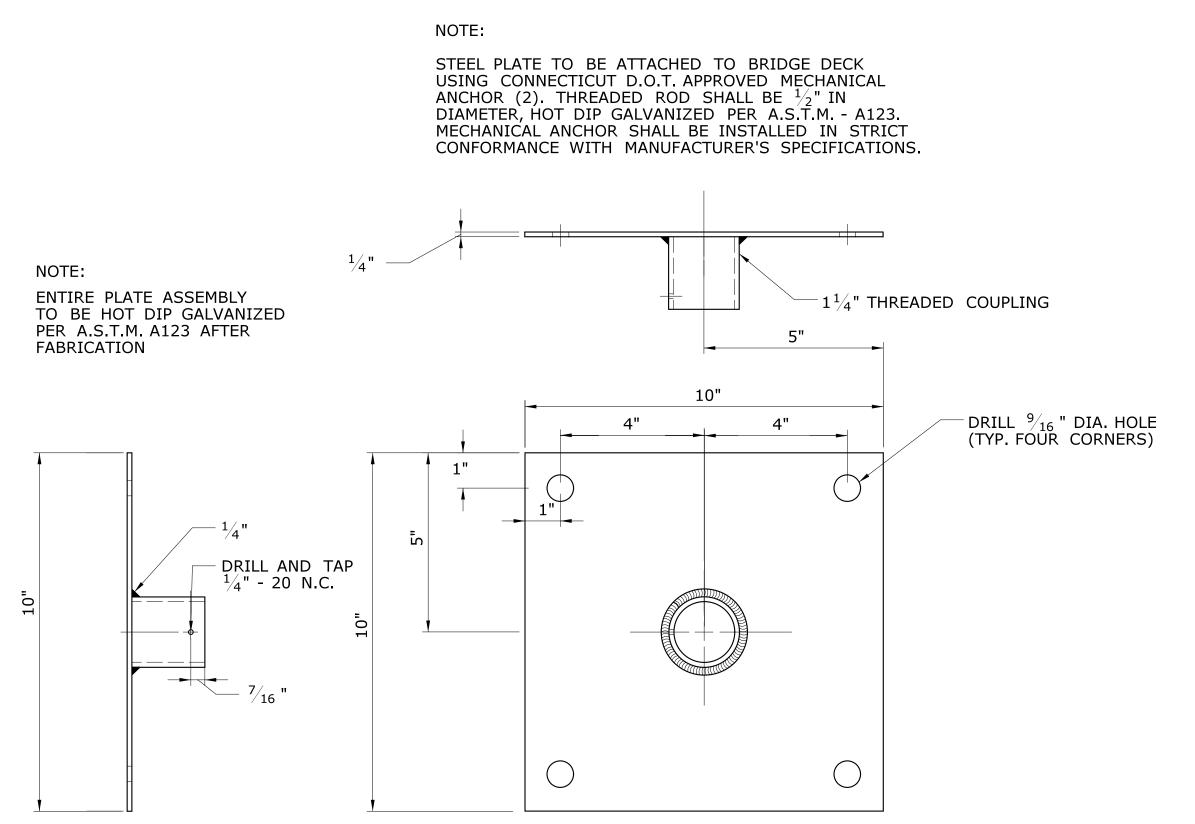


# STEEL PLATE FOR PENDANT LUMINAIRE

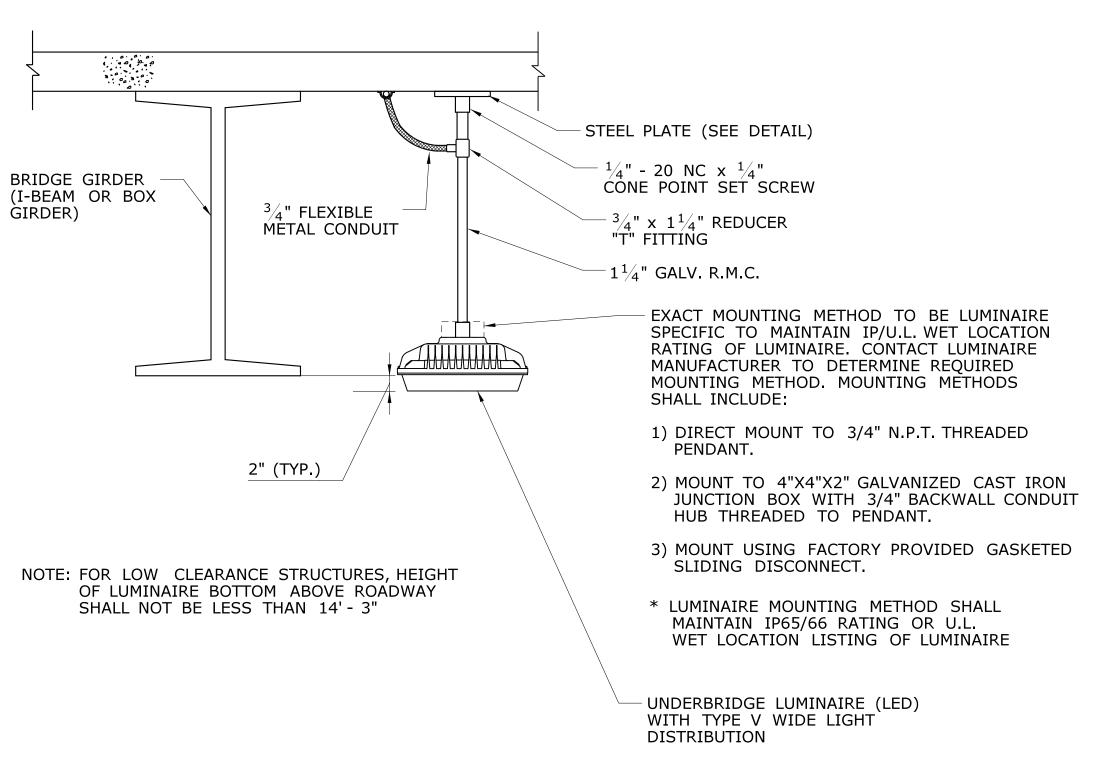


### 1/2" LIQUID TIGHT FLEXIBLE METAL CONDUIT TO LIGHT POLE - 3 #10 (DISCONNECT FEED FROM EXISTING JUNCTION BOX) TO LUMINAIRE INSULATED FUSE HOLDER INSTALL NEW W/10 AMP FUSE IN 16"X14"X6" NEMA 4X FIBERGLASS JUNCTION FIBERGLASS JUNCTION EXISTING JUNCTION BOX (TYP.) BOX TO BE ABANDONED SPLIT BOLT 2" FIBERGLASS CONDUIT -CONNECTOR (TYP.) 3 #2, 1 #8 BARE CU GND. BLACK & RED - PHASE AB RED & BLUE - PHASE BC BLUE & BLACK - PHASE CA 3 PHASE 3 WIRE SYSTEM <sup>3</sup>/<sub>4</sub>" FIBERGLASS CONDUIT TO UNDERBRIDGE LUMINAIRE W/ 3#10

### TYPICAL LAYOUT AND FEED FOR UNDERBRIDGE LUMINAIRE

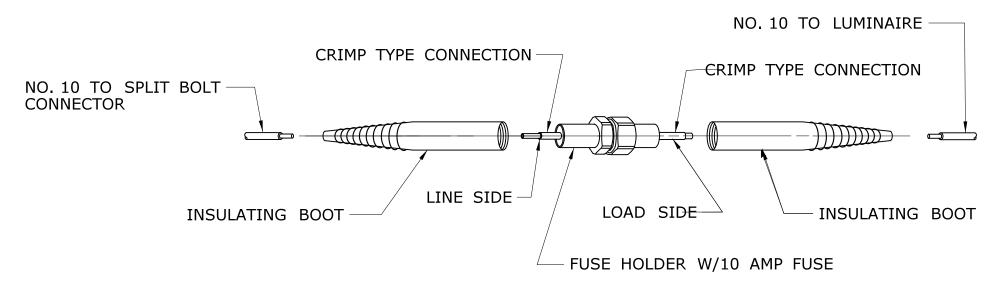

# INSULATED FUSE CONNECTOR

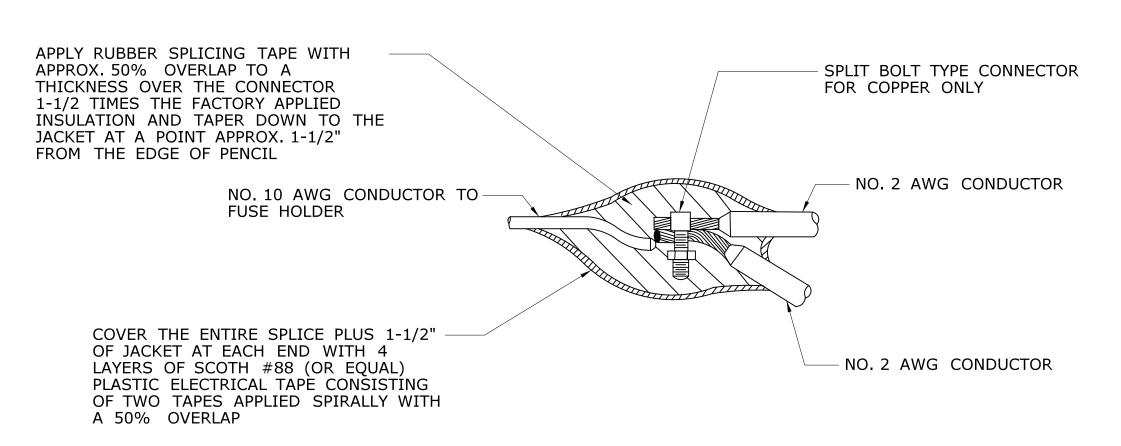

## SPLIT BOLT CONNECTOR

### UNDERBRIDGE LIGHTING NOTES:

- 1. EXISTING LIGHTING CIRCUITRY IS 480 VOLT, 3 PHASE.
- 2. ALL ELECTRICAL WORK SHALL CONFORM TO THE NATIONAL ELECTRIC CODE, CONNECTICUT STANDARD SPECIFICATIONS, AND WHERE APPLICABLE, UTILIITY COMPANY REGULATIONS.
- 3. CONDUCTORS SHALL BE COPPER, INSULATION TYPE THWN AND RATED FOR 600 VOLTS. INSULATION SHALL BE FULL LENGTH FACTORY COLOR CODED AS FOLLOWS: RED, BLACK, BLUE.
- 4. THE CONTRACTOR SHALL ABIDE BY THE CONNDOT LOCKOUT/TAGOUT PROCEEDURES. THE CONTRACTOR SHALL CONTACT THE DISTRICT ELECTRICAL SUPERVISOR AT TELEPHONE (860) 566-3156, WHEN ACCESS TO A CIRCUIT IS REQUIRED AND TO MARK-OUT EXISTING UNDERGROUND LIGHTING CIRCUITS.
- 5. REMOVE AND DISPOSE OF EXISTING UNDERBRIDGE LIGHTS, SURFACE CONDUIT AND CONDUCTORS.
- 6. INSTALL 3#4" LIQUID TIGHT FLEXIBLE METAL CONDUIT AT ALL LOCATIONS SUBJECT TO MOVEMENT OR EXPANSION.

# UNDERBRIDGE LUMINAIRE - PENDANT MOUNTING


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REV.	DATE	REV	ISION DI	ESCRIPTION	SHEET	NO.	Plotted Date: 7/5/2016

SIGNER/DRAFTER: MD
ECKED BY: SDH

SCALE AS NOTED



Filename: ...\LTG-07\_63-699.dgn

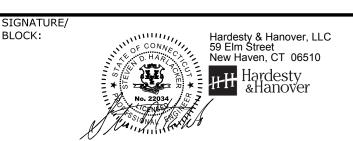

BRIDGE NO. 03160A-D, 3301 & 3303 I-84 EB/WB OVER AMTRAK & LOCAL ROADS (AETNA VIADUCT)

HARTFORD


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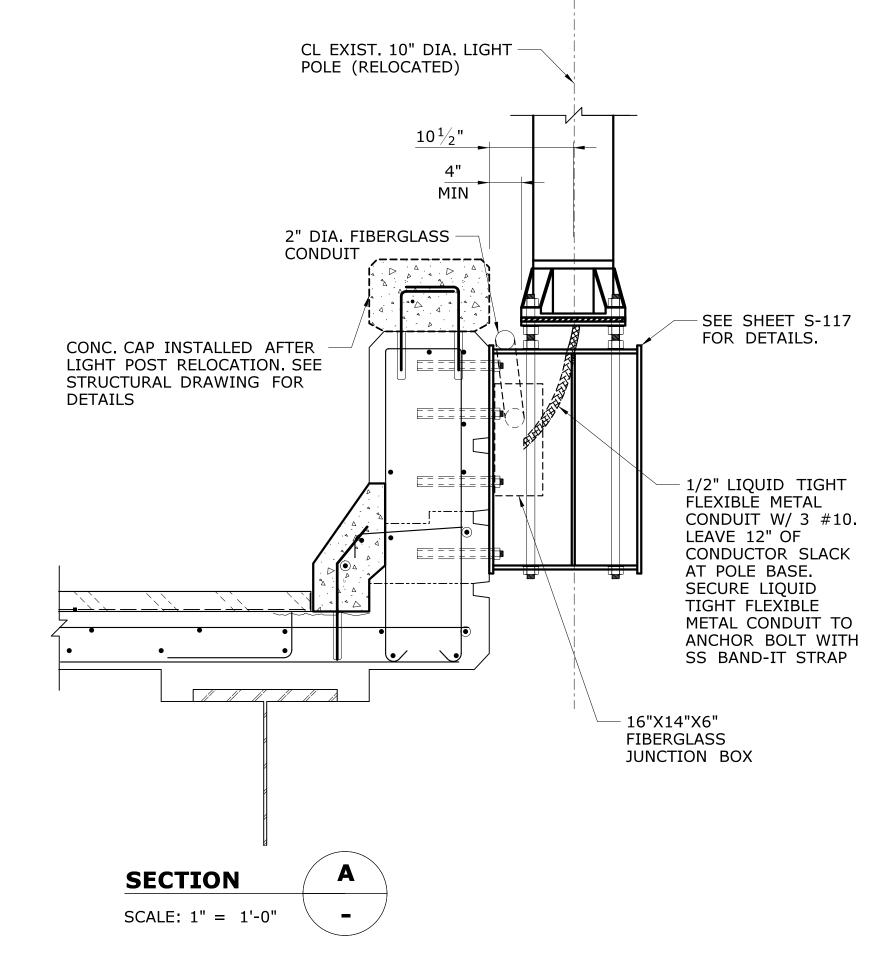
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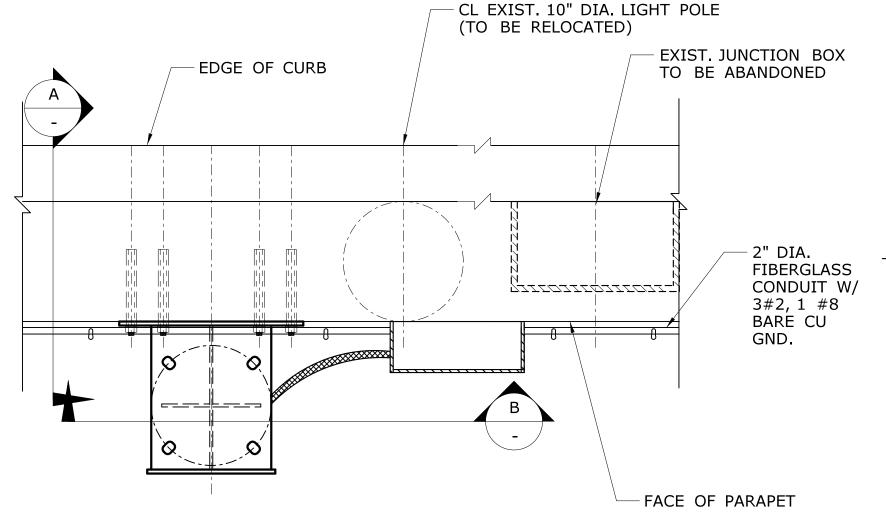
01.10.07



# TYPICAL CONDUIT TREATMENT AT EXISTING CONCRETE HANDHOLE OR STANDARD FOUNDATION (TOP VIEW)



SHEET NO. Plotted Date: 7/5/2016

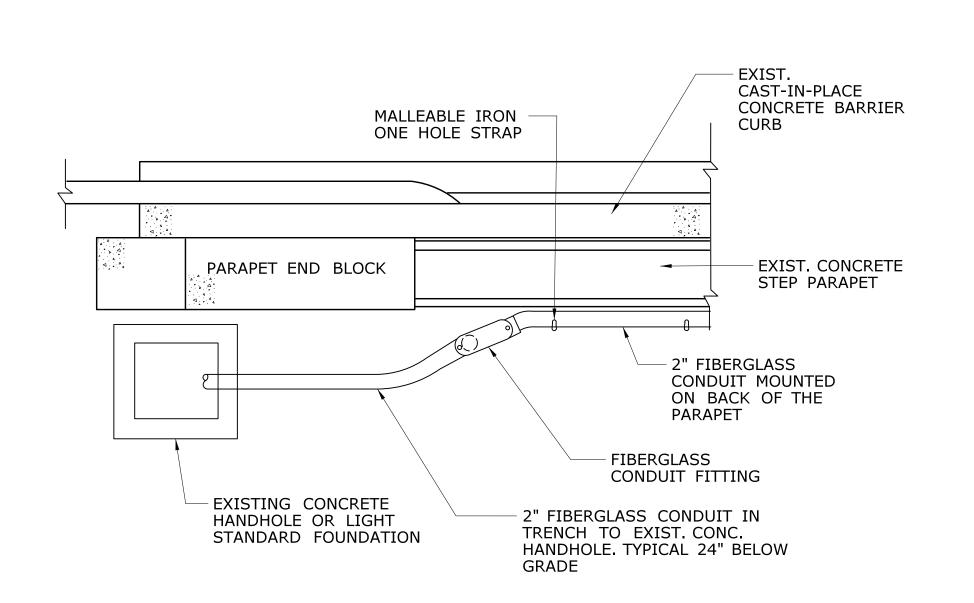

# PARAPET PLAN

SCALE: NTS

SEE STRUCTURAL DRAWINGS FOR STRUCTURAL DETAIL.


### ALUMINUM LIGHT STANDARD - DIMENSION TABLE SHAFT DIAMETER MOUNTING | BRACKET SHAFT WALL BASE TYPE ANCHOR BOLT **BOLT CIRCLE** HEIGHT LENGTH THICKNESS BOTTOM | TOP SIZE DIAMETER 40' .219" ANCHOR 15" 12' 10" 6"

### **LIGHT STANDARD NOTES:**


- ALUMINUM ALLOY SHALL BE 6063, T6 TEMPER.
- BOLT CIRCLE SHOWN IS FOR ANCHOR BASE BOTTOM OR TRANSFORMER BASE BOTTOM (WHICHEVER IS APPLICABLE).
- 3) TO BE DESIGNED TO AASHTO "STANDARD SPECIFICATION FOR STRUCTURAL SUPPORTS FOR HIGHWAY SIGNS, LUMINAIRES AND TRAFFIC SIGNALS" FOR 90 M.P.H. WINDS.
- WELDING DESIGN AND FABRICATION SHALL CONFORM TO THE LATEST EDITION OF THE ANSI/AWS D1.2, STRUCTURAL WELDING CODE - ALUMINUM.
- FOR BASE CONNECTION WELDS, FABRICATION INSPECTION AND TESTING SHALL BE PERFORMED AS NECESSARY PRIOR TO ASSEMBLY, DURING ASSEMBLY, DURING WELDING, AND AFTER WELDING, TO ENSURE THAT MATERIALS AND WORKMANSHIP MEET THE REQUIREMENTS OF THE CONTRACT DOCUMENTS. FABRICATION INSPECTION AND TESTING IS THE RESPONSIBILITY OF THE CONTRACTOR. VERIFICATION INSPECTION AND TESTING IS THE PREROGATIVE OF THE ENGINEER (CONNDOT).
- NON-DESTRUCTIVE TESTING FOR ALUMINUM SHALL BE AS FOLLOWS: A RANDOM 25% OF ALL BASE CONNECTION WELDS SHALL BE INSPECTED IN ACCORDANCE WITH ASTM E-165 STANDARD PRACTICE FOR LIQUID PENETRANT INSPECTION METHOD.

**ALUMINUM** 

POLE CAP

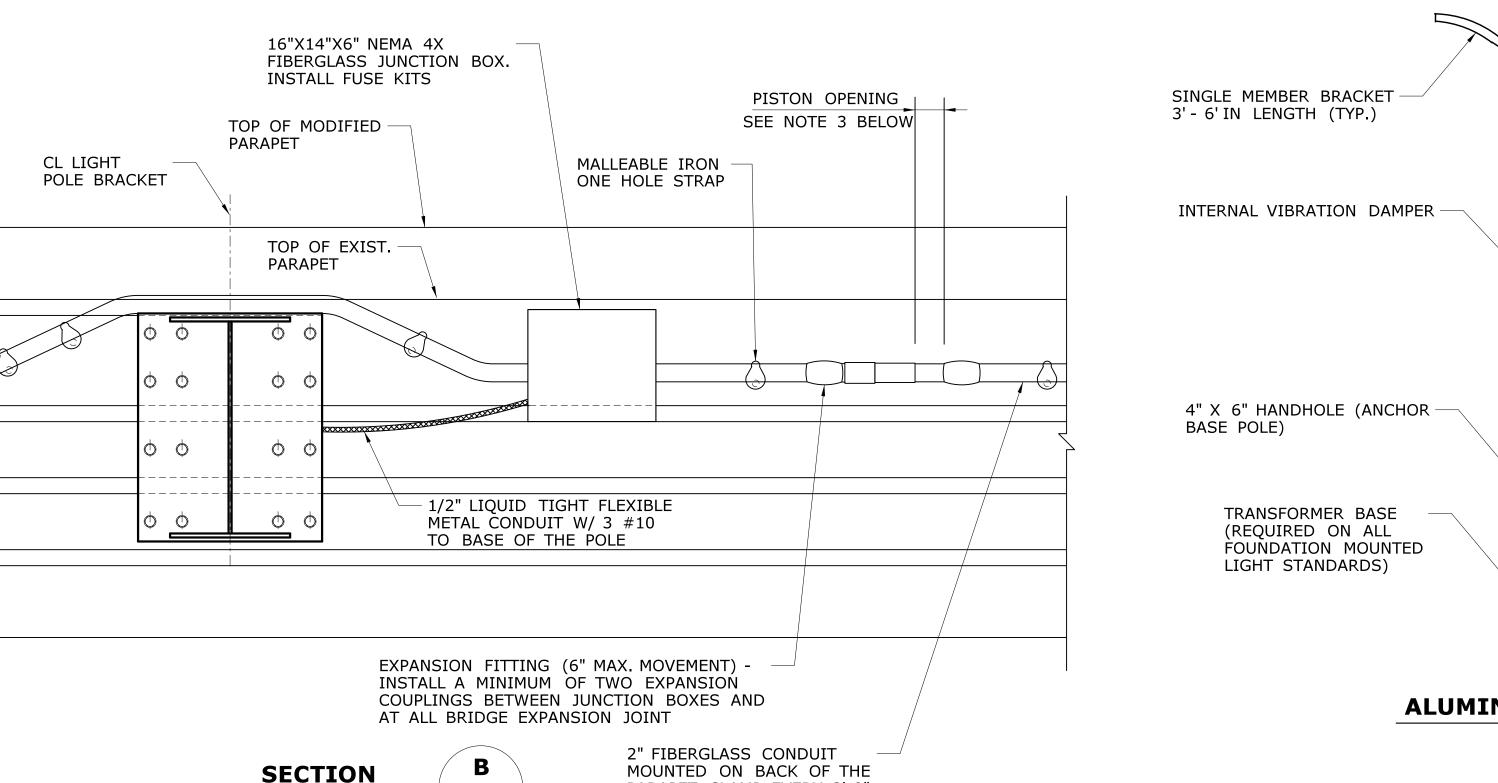

PARAPET. CLAMP EVERY 3'-0"

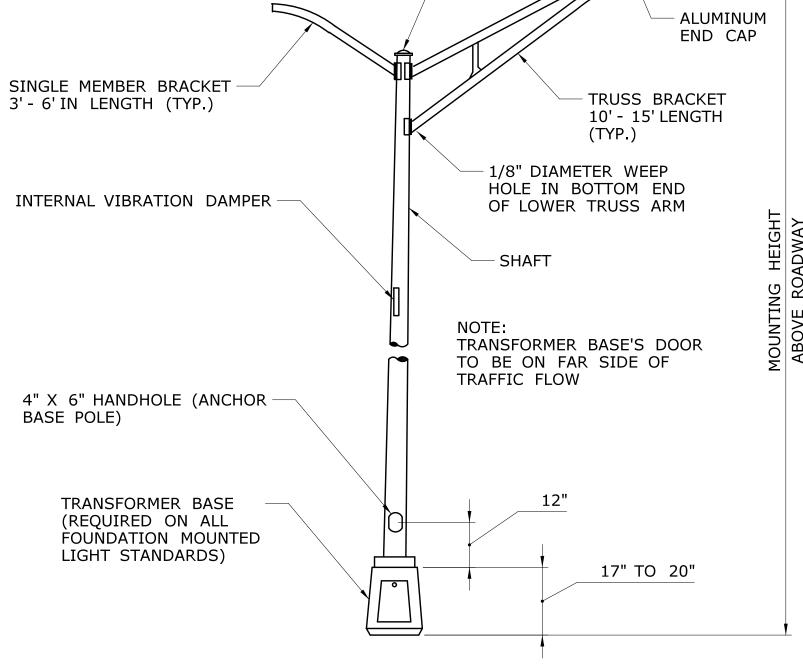

# ALUMINUM LIGHT STANDARD

BOLT CIRCLE DIAMETER	BOLT SPACING		
15"	105/8"		
17"	12"		

### CONDUIT ATTACHMENT NOTES:

1. SURFACE MOUNTED FIBERGLASS CONDUIT SUPPORT SPACING SHALL NOT EXCEED 3'-0" AS PER N.E.C. 352.30(B). WHEN THE FIBERGLASS CONDUIT LENGTH IS BETWEEN 50' AND 200' INSTALL TWO CONDUIT EXPANSION FITTINGS EQUALLY SPACED FROM EACH OTHER AND THE ENDS OF THE CONDUIT RUN. CONDUIT EXPANSION FITTINGS SHALL BE INSTALLED IN STRICT CONFORMANCE WITH THE MANUFACTURERS INSTALLATION GUIDELINES.

SCALE: NTS

- CONDUIT EXPANSION FITTINGS (6" MOVEMENT) SHALL BE INSTALLED AT ALL BRIDGE EXPANSION JOINTS. A MINIMUM OF TWO CONDUIT EXPANSION FITTINGS SHALL BE INSTALLED BETWEEN EACH JUNCTION BOX AS INDICATED IN THE DETAILS. MAXIMUM SPACING BETWEEN ADJACENT EXPANSION FITTINGS SHALL NOT EXCEED 125'. BARREL END OF EXPANSION FITTING SHALL BE SECURELY CLAMPED TO THE PARAPET TO PROHIBIT MOVEMENT OF BARREL.
- EXPANSION FITTING PISTON OPENING AT THE TIME OF INSTALLATION SHALL BE DETERMINED BASED ON THE FOLLOWING FORMULA
  - $= \frac{100 \text{ F}^{\circ} \text{AMBIENT TEMP.}}{100 \text{ F}^{\circ}} \times 6"$
- ALL CONDUIT FITTINGS, COUPLINGS, CLAMPS, ATTACHMENT HARDWARE, DRILLING AND ANCHORING SHALL BE INCLUDED IN THE PRICE OF THE CONDUIT.

-	-	-	-	THE INFORMATION, INCLUDING ESTIMATED
_	-	-	_	QUANTITIES OF WORK, SHOWN ON THESE SHEETS IS BASED ON LIMITED
_	_	-	-	INVESTIGATIONS BY THE STATE AND IS IN NO WAY WARRANTED TO INDICATE
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-	-	-	_	OF WORK WHICH WILL BE REQUIRED.
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REVISION DESCRIPTION

REV. DATE

MD **SDH** 

SCALE AS NOTED

STATE OF CONNECTICUT **DEPARTMENT OF TRANSPORTATION** 



BRIDGE NO. 03160A-D, 3301 & 3303 I-84 EB/WB OVER AMTRAK

	TOWN: HARTFORD	PROJECT NO. <b>63-69</b> !
	DRAWING TITLE:	LTG-08
)	LIGHTING DETAIL - 2	SHEET NO. <b>01.10.0</b>

Filename: ...\LTG-08\_63-699.dgn

& LOCAL ROADS (AETNA VIADUCT